


Safety is a Part  
of Your Contract


GENERAL NOTES:

1. ALL REFERENCES TO WALL LINE (W/L) REFER TO THE CENTERLINE OF THE EXISTING SHEET PILE WALL ON THE ORLEANS LEVEE OF THE 17TH STREET CANAL. STATIONING ALONG THE WALL IS BASED ON THE THEORETICAL WIDTH OF THE SHEETS (BZ12.1L AND HOESCH 12 ARE 22.64'; PMA-22 IS 19.625').
2. ELEVATIONS REFER TO NATIONAL GEODETIC VERTICAL DATUM (N.G.V.D.). ELEVATION AT U.S.C.E. MONUMENT 14 IS 8.77 N.G.V.D..
3. NORMAL WATER SURFACE ELEVATION RANGE IS FROM EL.1.5 TO EL.2.0 (N.G.V.D.).
4. REFERENCES TO THE PROTECTED SIDE OF THE LEVEE REFER TO THE LAND SIDE OF THE LEVEE. REFERENCES TO THE FLOOD SIDE OF THE LEVEE REFER TO THE CANAL OR LAKE SIDE OF THE LEVEE.
5. THE CONTRACTOR SHALL REMOVE THE COAL TAR EPOXY PAINT FROM THE EXISTING SHEET PILE AS SPECIFIED IN 'STEEL SHEET PILING' OF THE SPECIFICATIONS.
6. THE CONTRACTOR SHALL NOTE THE CLOSE PROXIMITY OF RESIDENCES, TREES, AND UTILITIES ALONG THE ENTIRE LENGTH OF THE PROJECT SITE. HE SHALL EXERCISE EXTREME CAUTION AT ALL TIMES WHEN WORKING ON THE LEVEE AND HE SHALL BE RESPONSIBLE FOR THE REPAIR OF ANY DAMAGE RESULTING FROM HIS OPERATIONS.
7. CONTRACTOR SHALL PROVIDE, ERECT, AND MAINTAIN A SAFETY FENCE AROUND THE CONSTRUCTION RIGHT-OF-WAY. SEE SPECIAL CLAUSE 'SAFETY PROVISIONS'.
8. SEE DRAWING 5 FOR BENCH MARK INFORMATION.

OBSTRUCTIONS TO R/W		
W/L STATION (APPROXIMATE)	ITEM AND OWNER	DISPOSITION
99+71	U.S. SPRINT FIBER OPTIC LINE	DWG. NO. 2
35+82	L.P. & L. POWER LINE	DWG. NO. 4

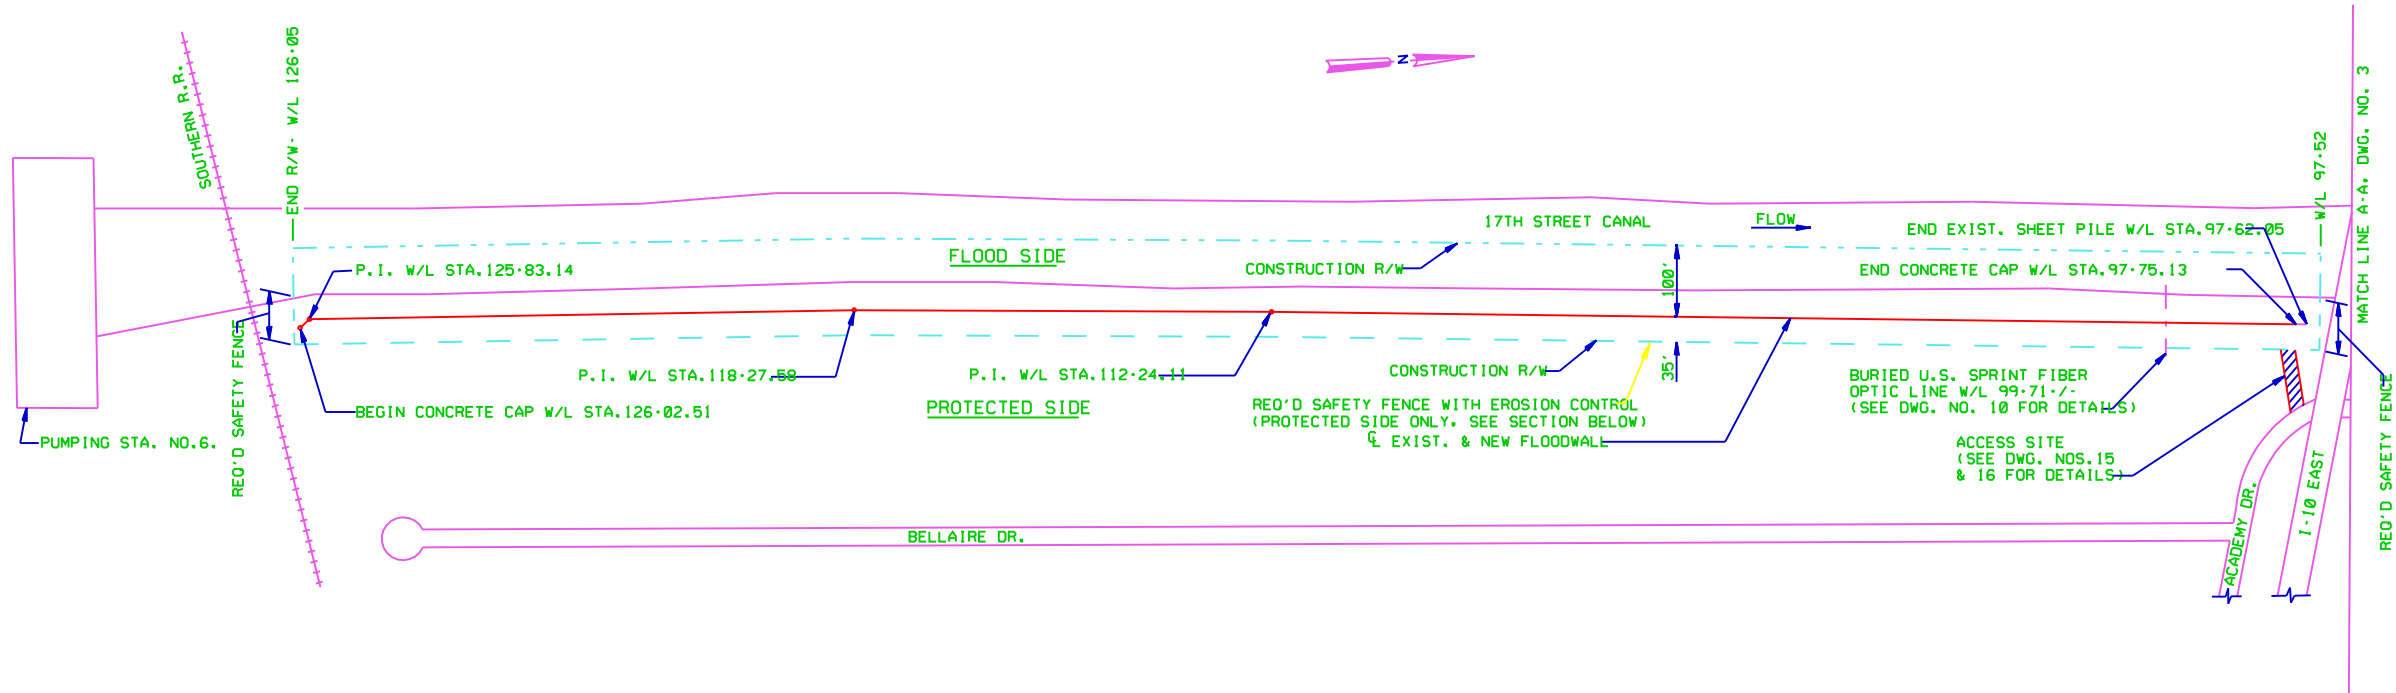

PLAN  
SCALE 1" = 100'-0"

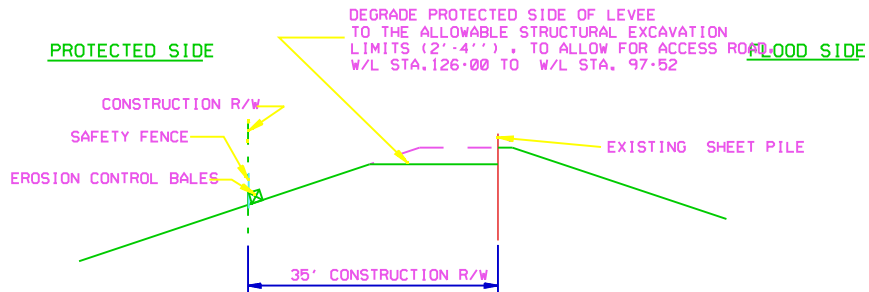

ACCESS AND STORAGE DETAILS

STA. 126+03 TO STA. 97+52  
SCALE 1" = 10'-0"  
ACCESS NOT SHOWN FOR CLARITY

EXCAVATED MATERIAL MUST BE HAULED IN ACCORDANCE WITH C2C OF THE SPECIFICATIONS AND STORED FOR REUSE IN ACCORDANCE WITH SPECIAL CLAUSE "OFFSITE STORAGE".

LEGEND

- SHEET PILE TO BE CAPPED
- SHEET PILE LEFT UNCAPPED
- CONSTRUCTION R/W
- UTILITY
- CONSTR. R/W, SAFETY FENCE, EROSION CONTROL
- CONSTR. R/W AND SAFETY FENCE

SCALE: 1" = 100'

100' 0 100' 200' 300' 400'

SCALE: 1" = 10'

10' 0 10' 20' 30' 40'

REVISIONS			
SYMBOL	DESCRIPTION	DATE	APPROVED
U.S. ARMY ENGINEER DISTRICT, NEW ORLEANS CORPS OF ENGINEERS NEW ORLEANS, LOUISIANA			
BOARD OF LEVEE COMMISSIONERS ORLEANS LEVEE DISTRICT NEW ORLEANS, LOUISIANA		MODJESKI & MASTERS INC. NEW ORLEANS, LOUISIANA	
LAKE PONTCHARTRAIN, LA. AND VICINITY HIGH LEVEL PLAN 17TH STREET CANAL EXCAVATION AND FLOODWALL PROTECTION CAPPING OF FLOODWALLS EAST SIDE LEVEE IMPROVEMENTS PLAN-1 AND GENERAL NOTES			
DESIGNED BY: F.S.	DATE: NOV. 1992	PLOT SCALE: 1200	PLOT DATE: APR 1993
DRAWN BY: P.M.R.	CADD FILE: H020002.DGN	FILE NO. H-4-40208	
CHECKED BY: M.L.S.	SOLICITATION NO. DACW29-93-B-0025	DWG. 2 OF 16	
SUBMITTED BY: W. B. CONWAY MODJESKI & MASTERS INC. DESIGN ENGINEER			

